

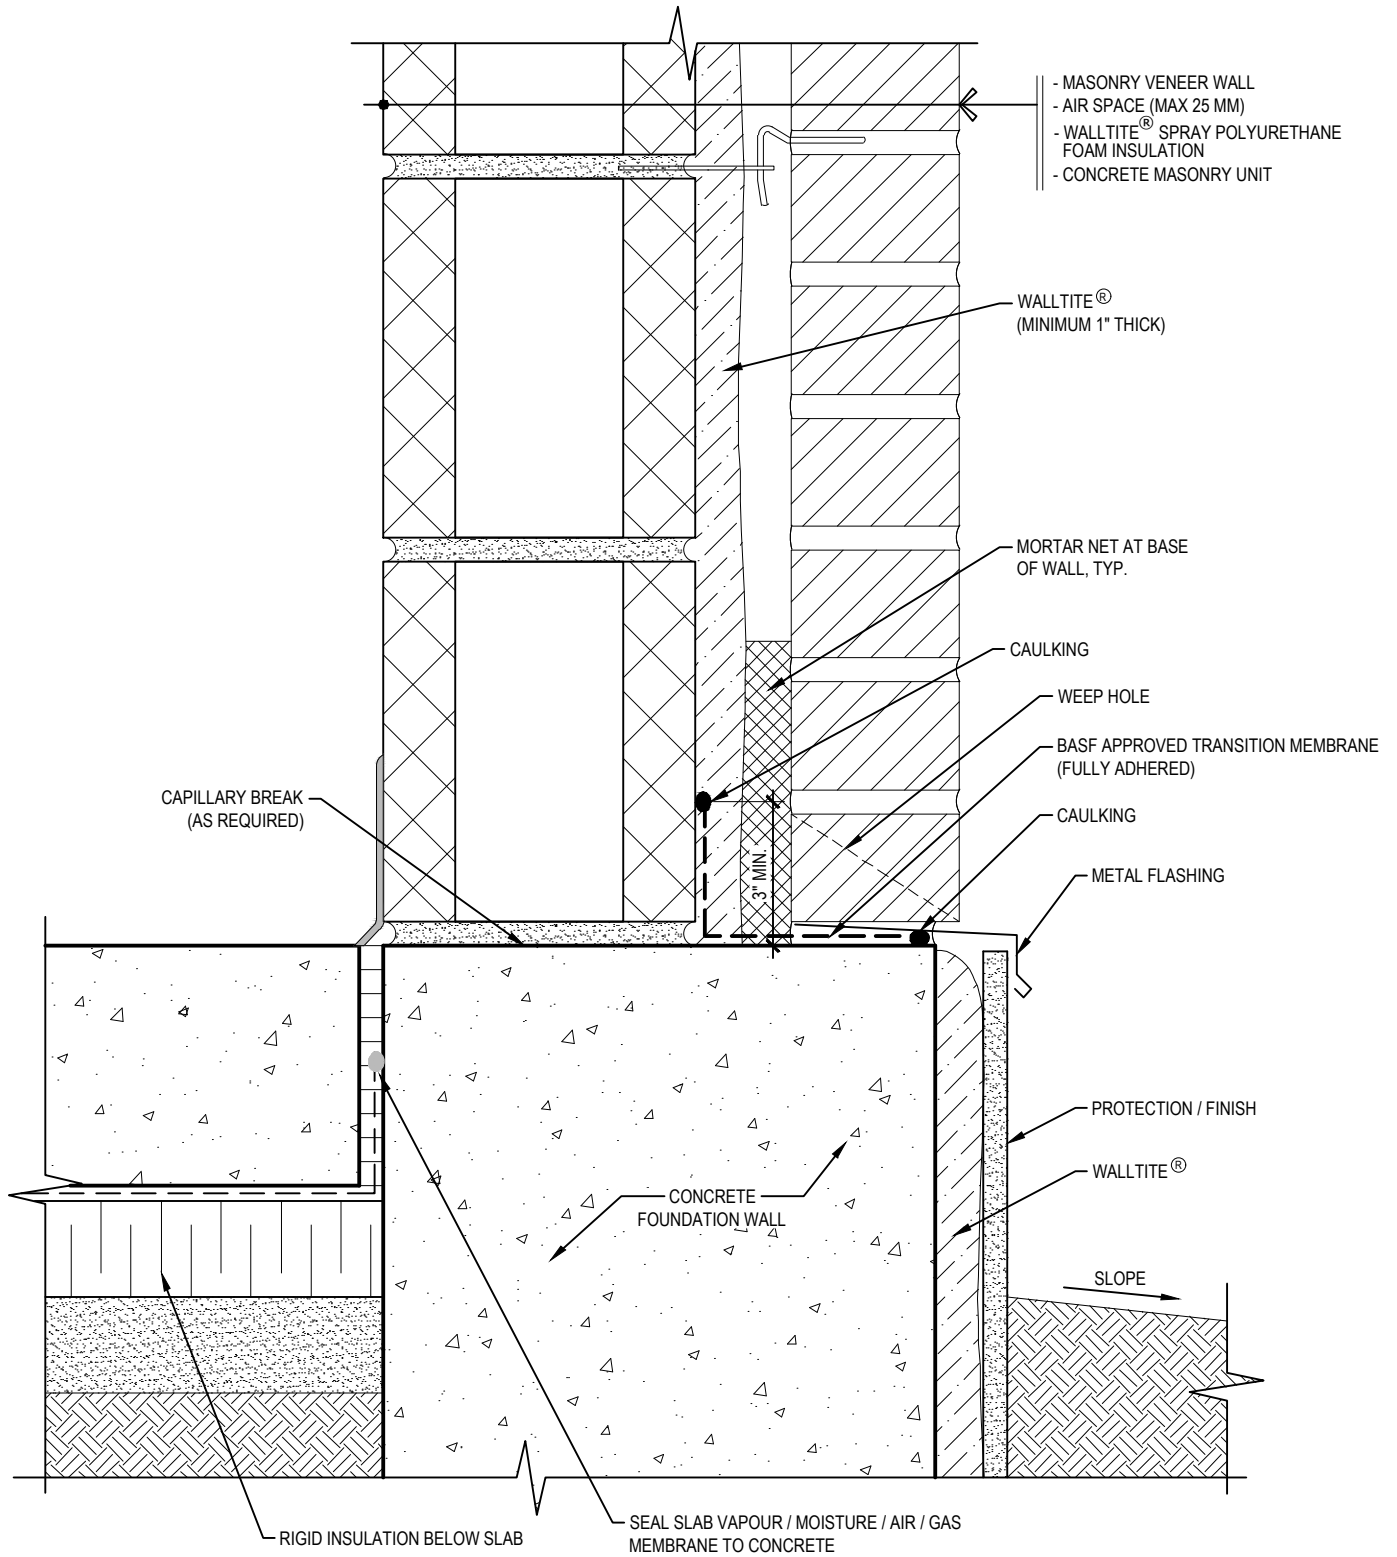
1  
WB-0

## WALL SECTION

WALLTITE® AIR BARRIER SYSTEM,  
CONCRETE BLOCK ASSEMBLY

**BASF**  
We create chemistry

Drawing Number: WB-0	Scale: 3/4" = 1'-0"	Project no: M18 704	Date: APRIL 3, 2019	Designed by: C.J. & A.M.	Drawn by: C.C	Checked by: F.D.
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1  
WB-1

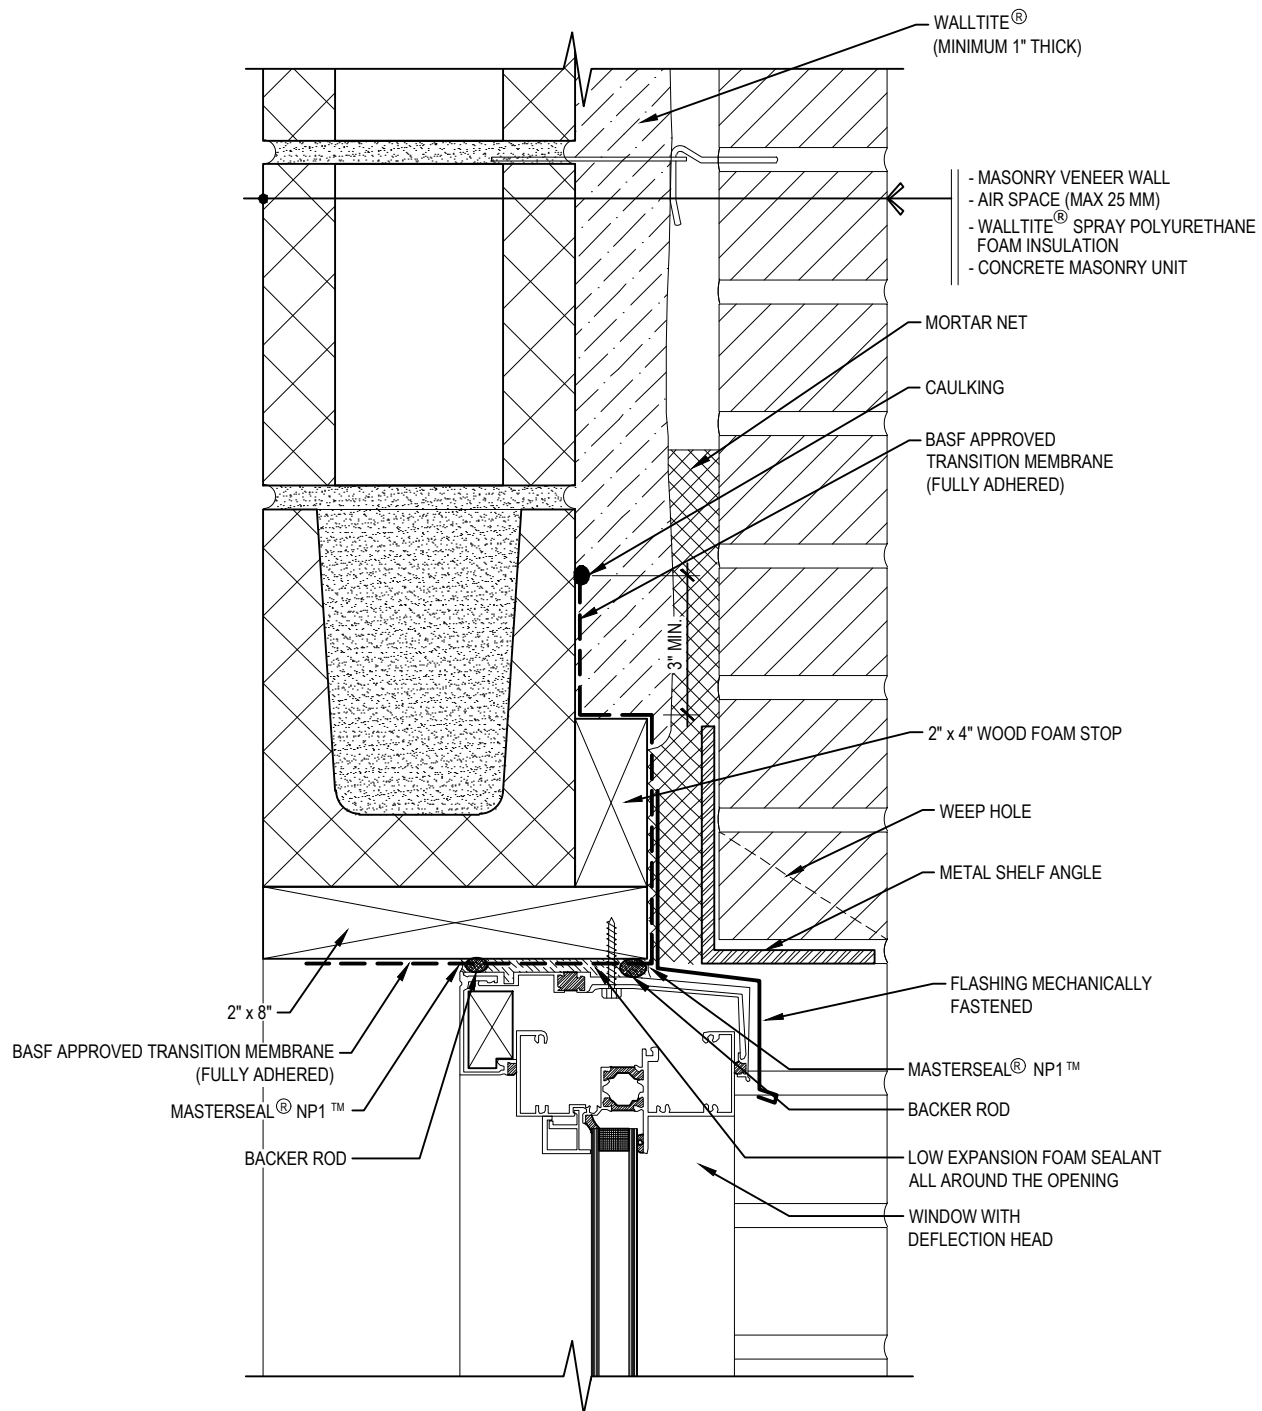
## FOUNDATION TERMINATION

WALLTITE® AIR BARRIER SYSTEM,  
CONCRETE BLOCK ASSEMBLY

**BASF**  
We create chemistry

Drawing Number:	Scale:	Project no:	Date:	Designed by:	Drawn by:	Checked by:
WB-1	3/4" = 1'-0"	M18 704	APRIL 3, 2019	C.J. & A.M.	C.C	F.D.

WINDOW INSTALLED AS PER CSA A440



1  
WB-2A

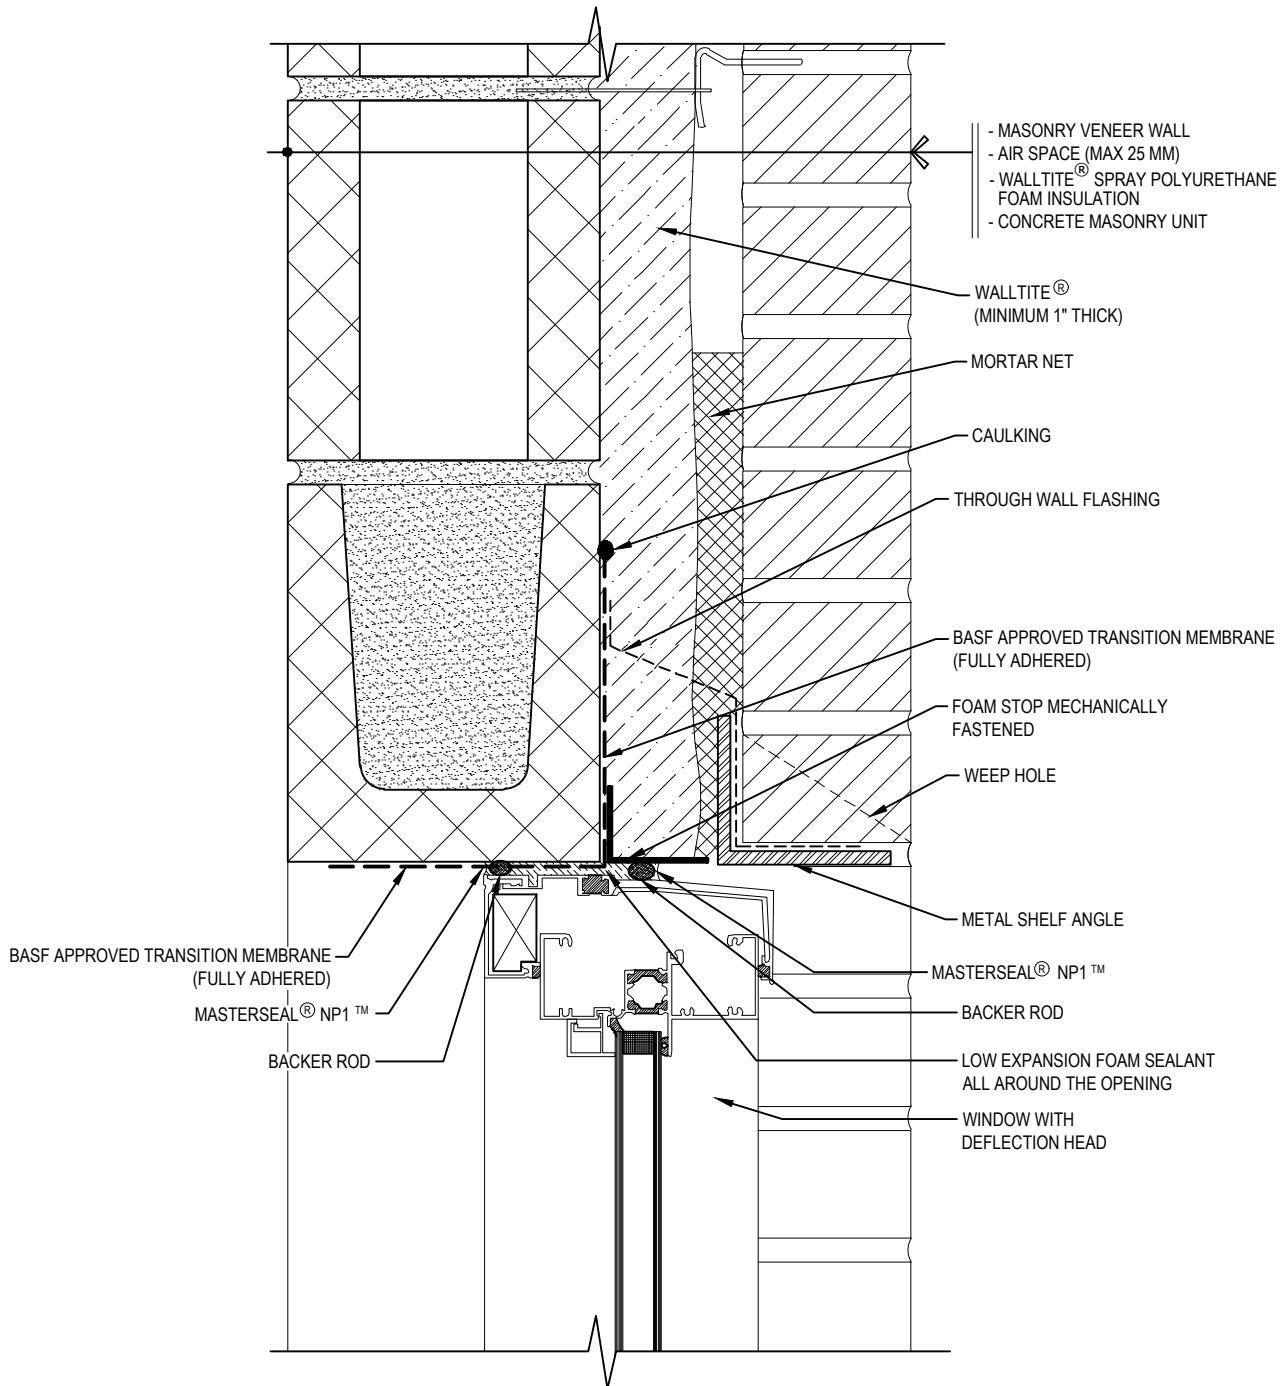
# WINDOW HEAD DETAIL WOOD FOAM STOP

WALLTITE® AIR BARRIER SYSTEM,  
CONCRETE BLOCK ASSEMBLY

**BASF**  
We create chemistry

Drawing Number: WB-2A	Scale: 3/4" = 1'-0"	Project no: M18 704	Date: OCTOBER 24, 2019	Designed by: C.J. & A.M.	Drawn by: C.C	Checked by: F.D.
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WINDOW INSTALLED AS PER CSA A440



1  
WB-2B

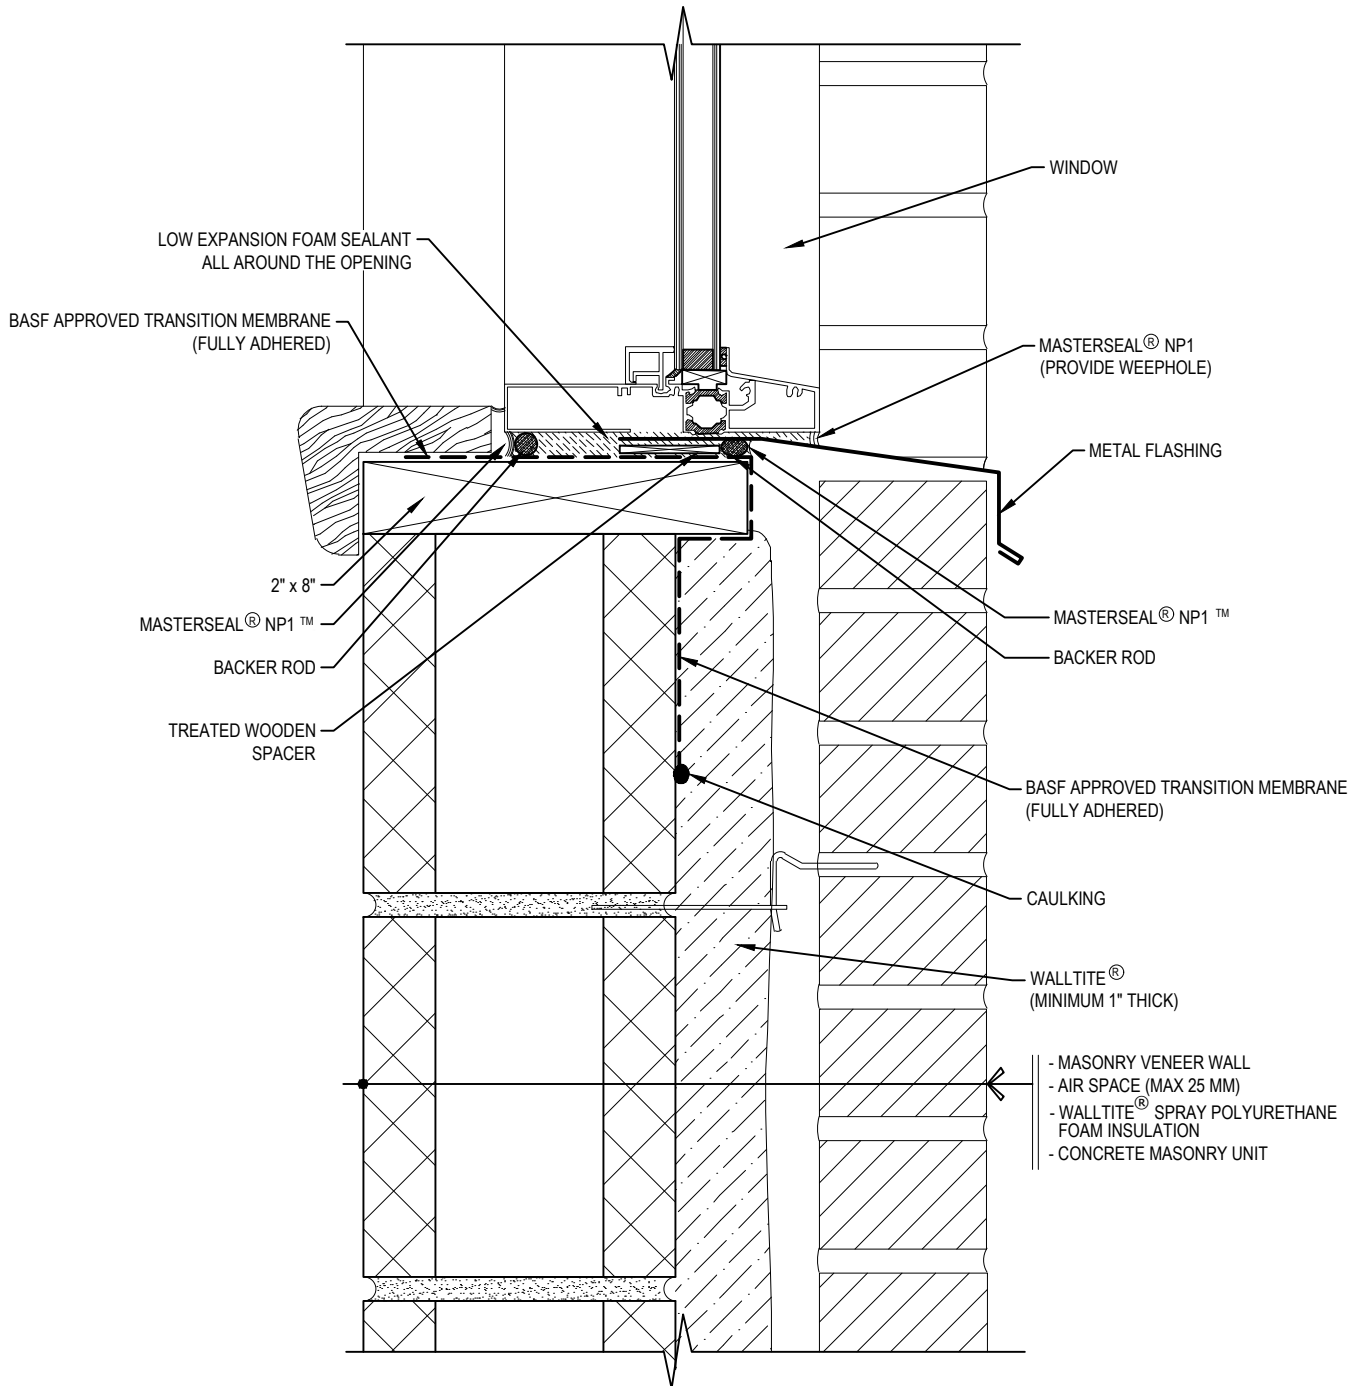
## WINDOW HEAD DETAIL METAL FOAM STOP

WALLTITE® AIR BARRIER SYSTEM,  
CONCRETE BLOCK ASSEMBLY

**BASF**  
We create chemistry

Drawing Number: WB-2B	Scale: 3/4" = 1'-0"	Project no: M18 704	Date: OCTOBER 24, 2019	Designed by: C.J. & A.M.	Drawn by: C.C	Checked by: F.D.
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WINDOW INSTALLED AS PER CSA A440



1  
WB-3A

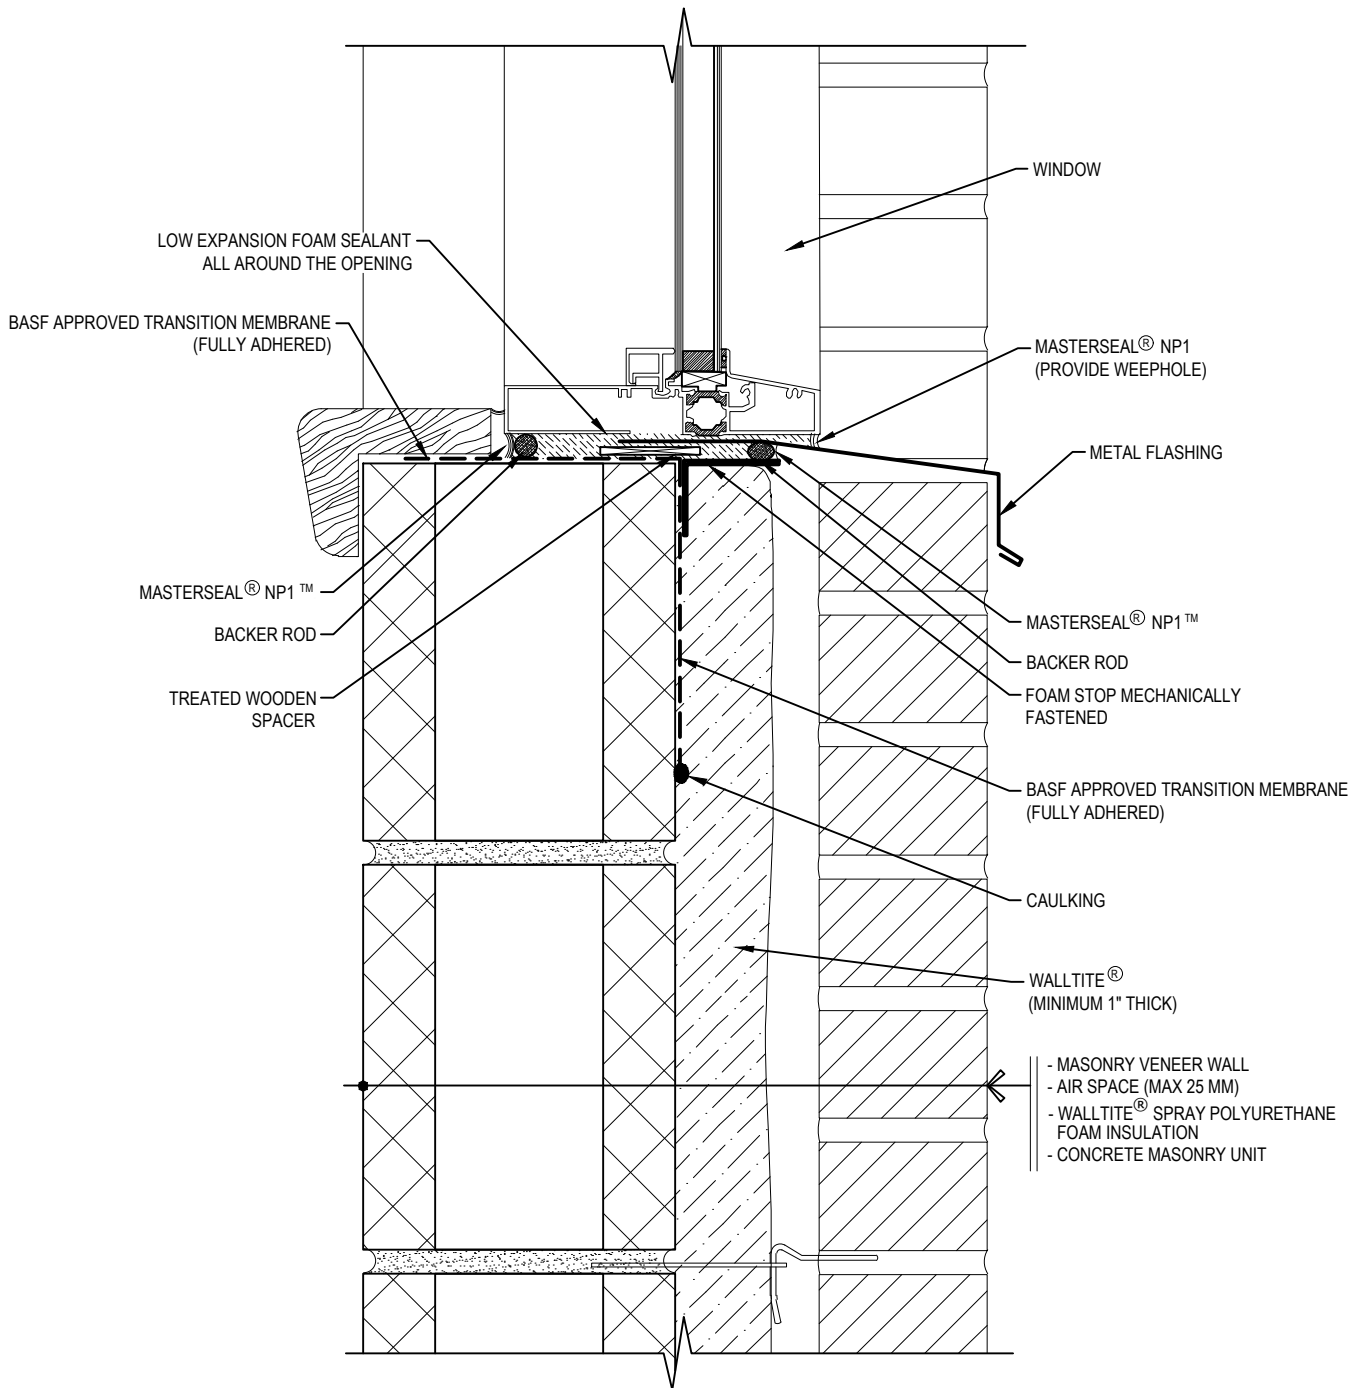
## WINDOW SILL DETAIL WOOD FOAM STOP

WALLTITE® AIR BARRIER SYSTEM,  
CONCRETE BLOCK ASSEMBLY

**BASF**  
We create chemistry

Drawing Number: WB-3A	Scale: 3/4" = 1'-0"	Project no: M18 704	Date: OCTOBER 24, 2019	Designed by: C.J. & A.M.	Drawn by: C.C	Checked by: F.D.
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WINDOW INSTALLED AS PER CSA A440



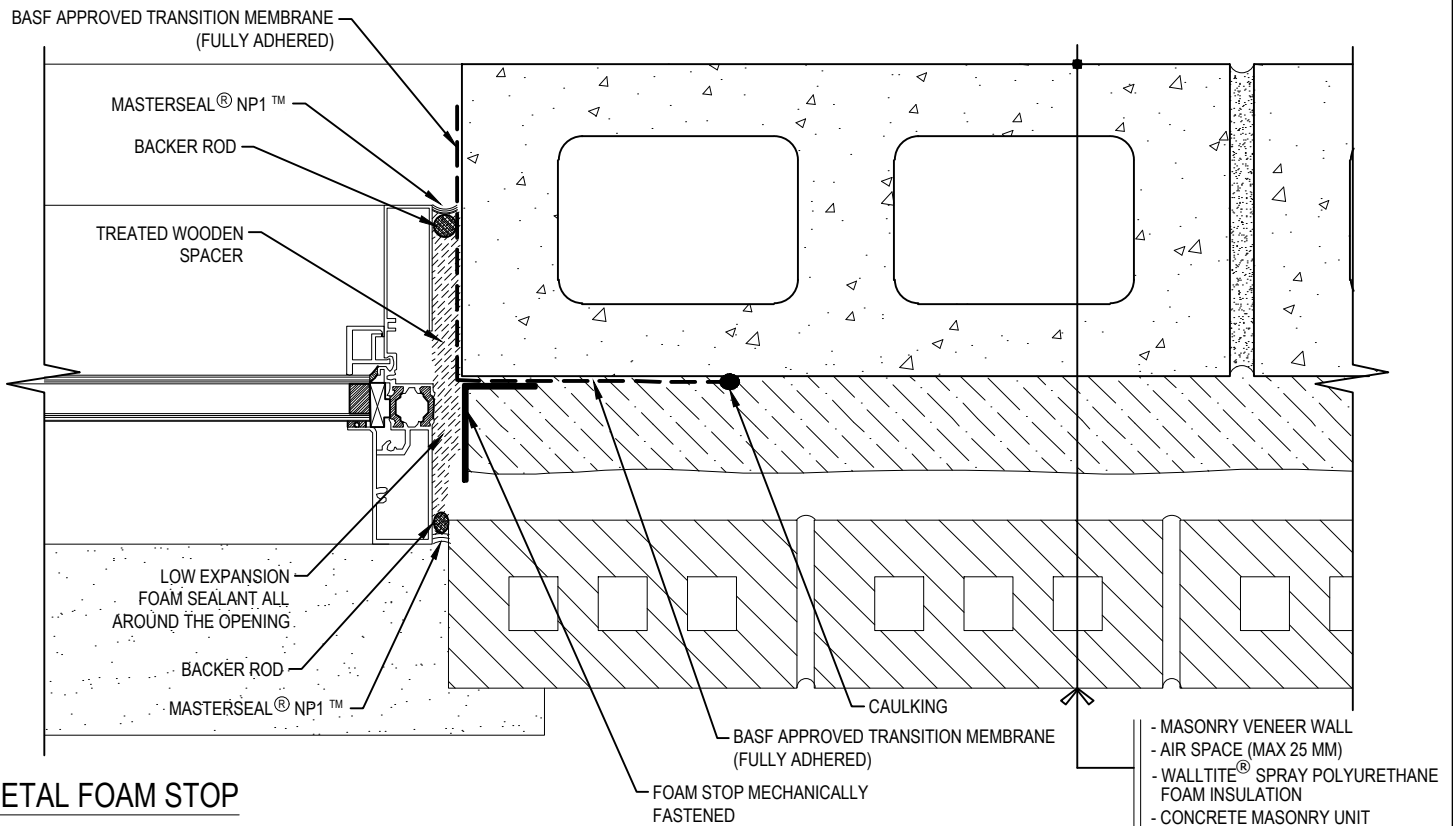
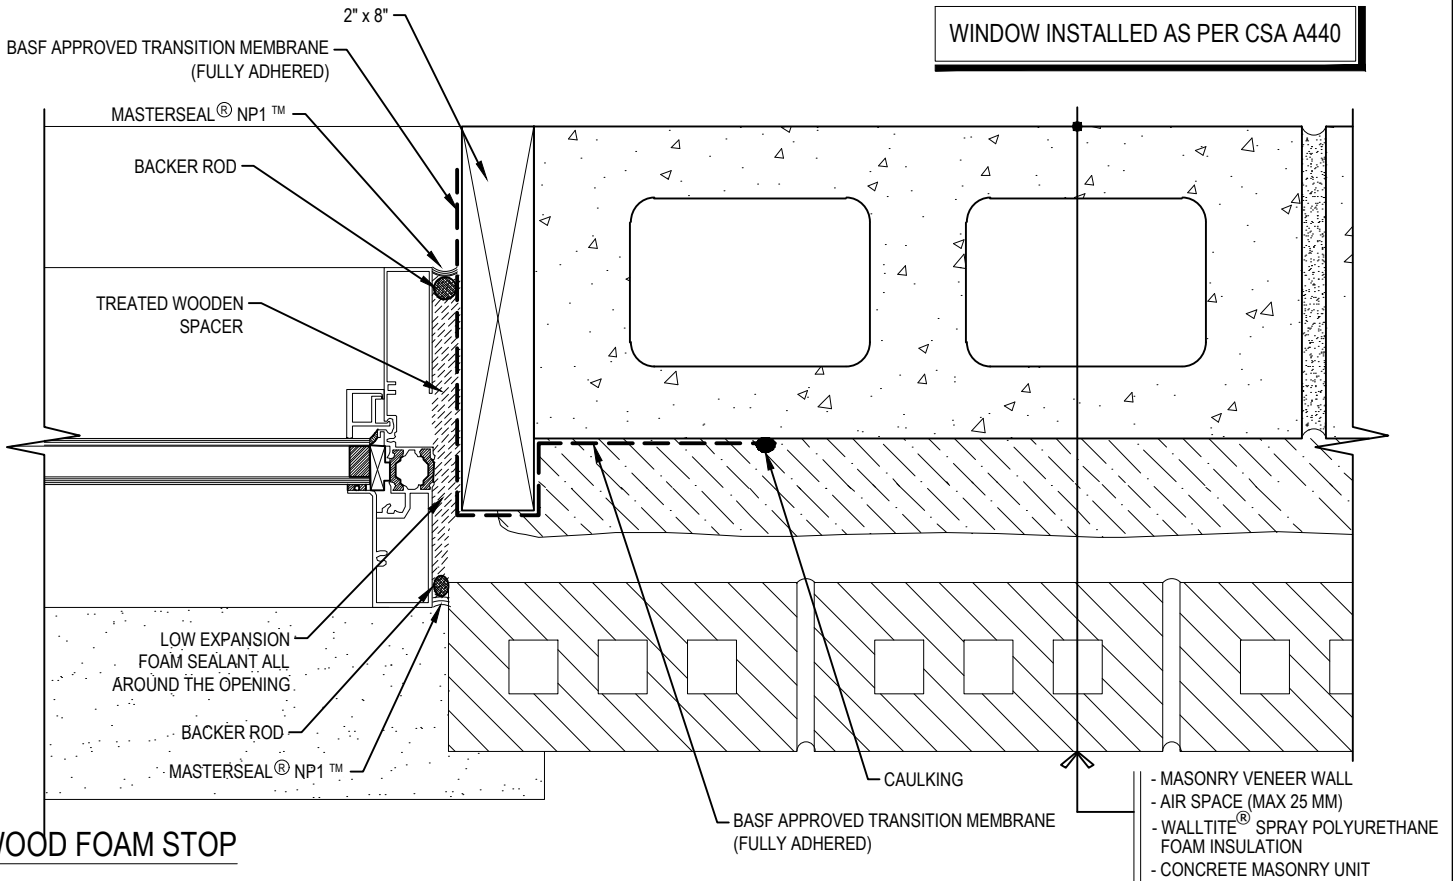
1  
WB-3B

WINDOW SILL DETAIL  
METAL FOAM STOP

WALLTITE® AIR BARRIER SYSTEM,  
CONCRETE BLOCK ASSEMBLY

**BASF**  
We create chemistry

Drawing Number: WB-3B	Scale: 3/4" = 1'-0"	Project no: M18 704	Date: OCTOBER 24, 2019	Designed by: C.J. & A.M.	Drawn by: C.C	Checked by: F.D.
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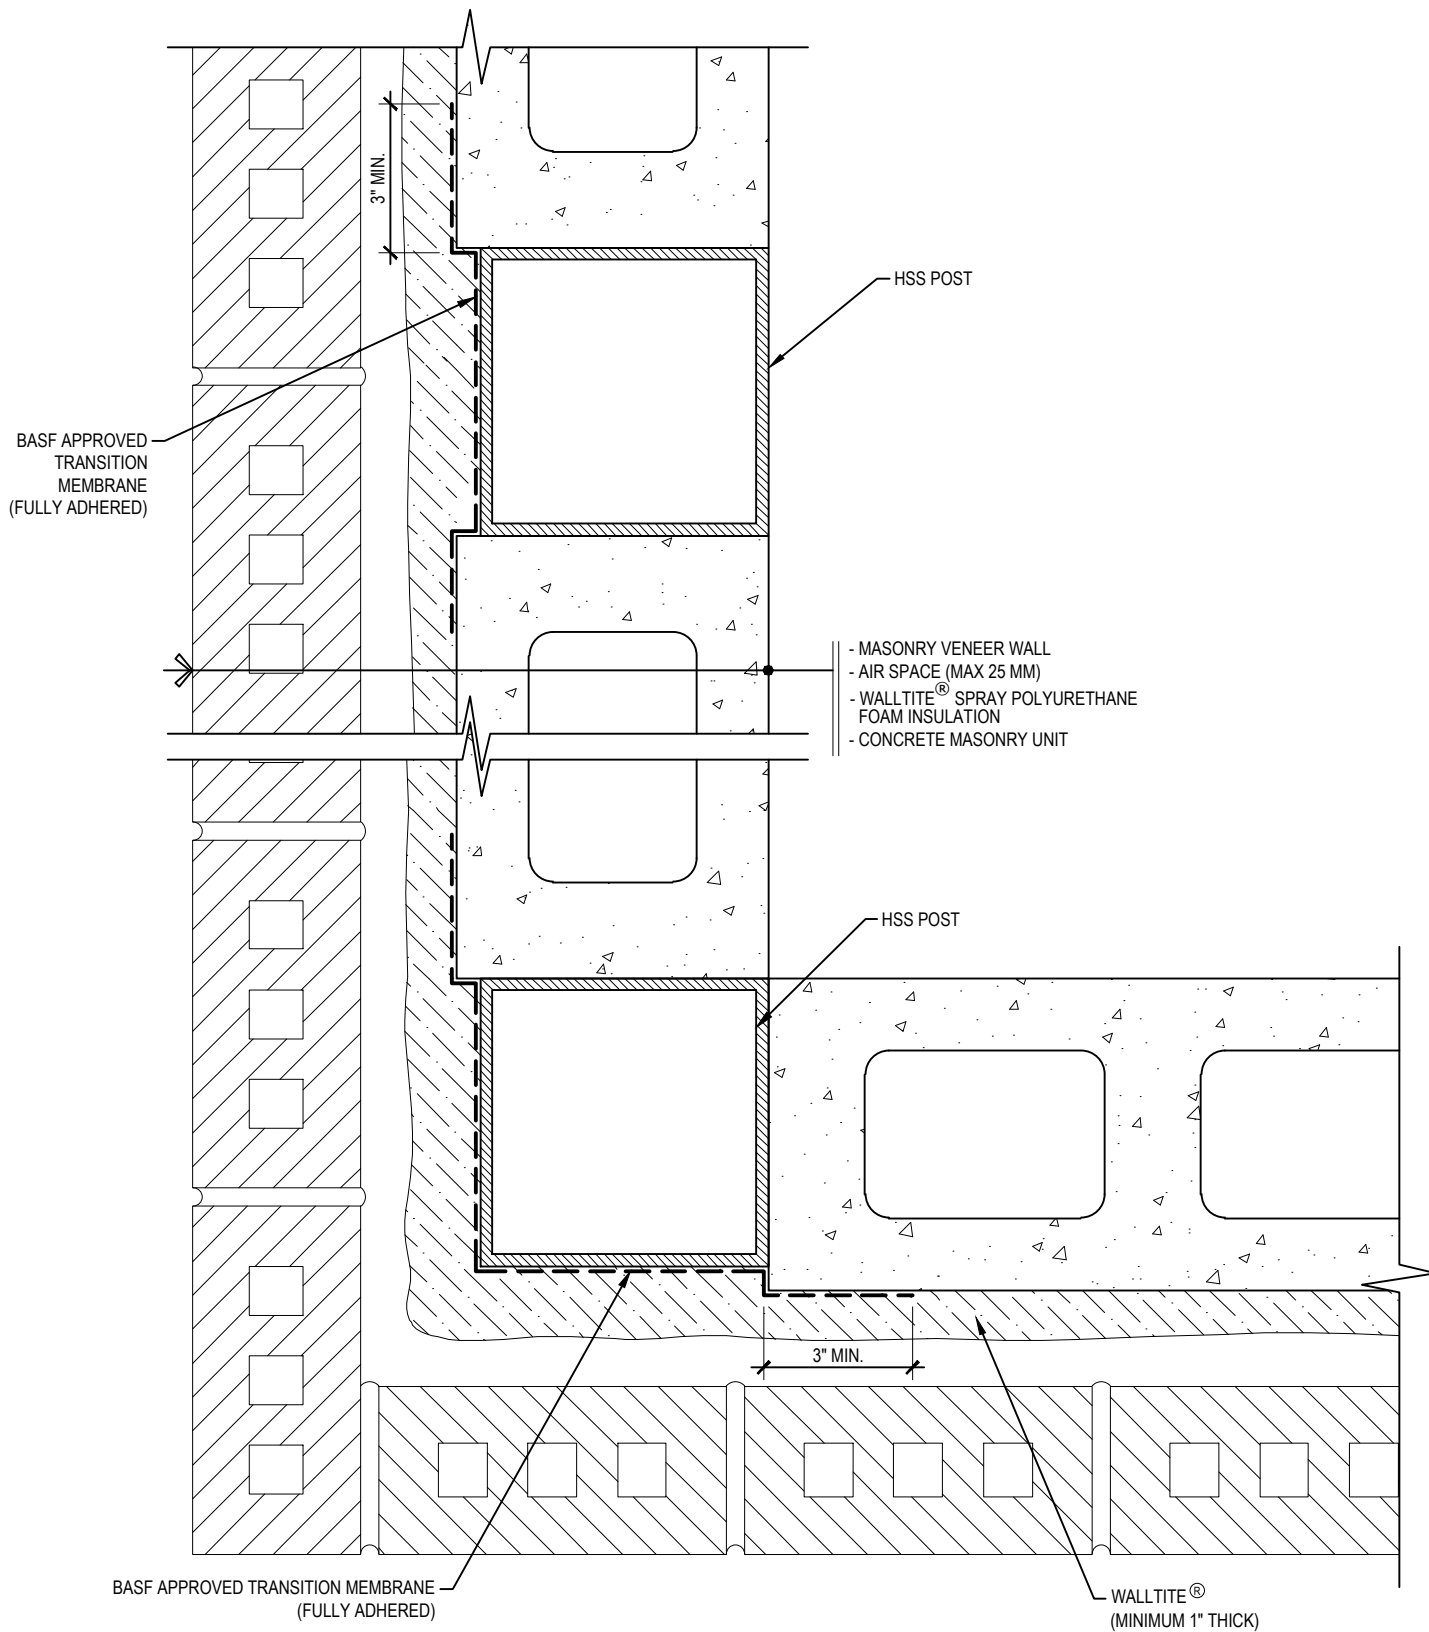
1  
WB-4

**WINDOW JAMB DETAIL**  
**WOOD AND METAL FOAM STOP**

**WALLTITE® AIR BARRIER SYSTEM,**  
**CONCRETE BLOCK ASSEMBLY**

**BASF**  
We create chemistry

Drawing Number: WB-4	Scale: 3/4" = 1'-0"	Project no: M18 704	Date: OCTOBER 24, 2019	Designed by: C.J. & A.M.	Drawn by: C.C	Checked by: F.D.
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1  
WB-5

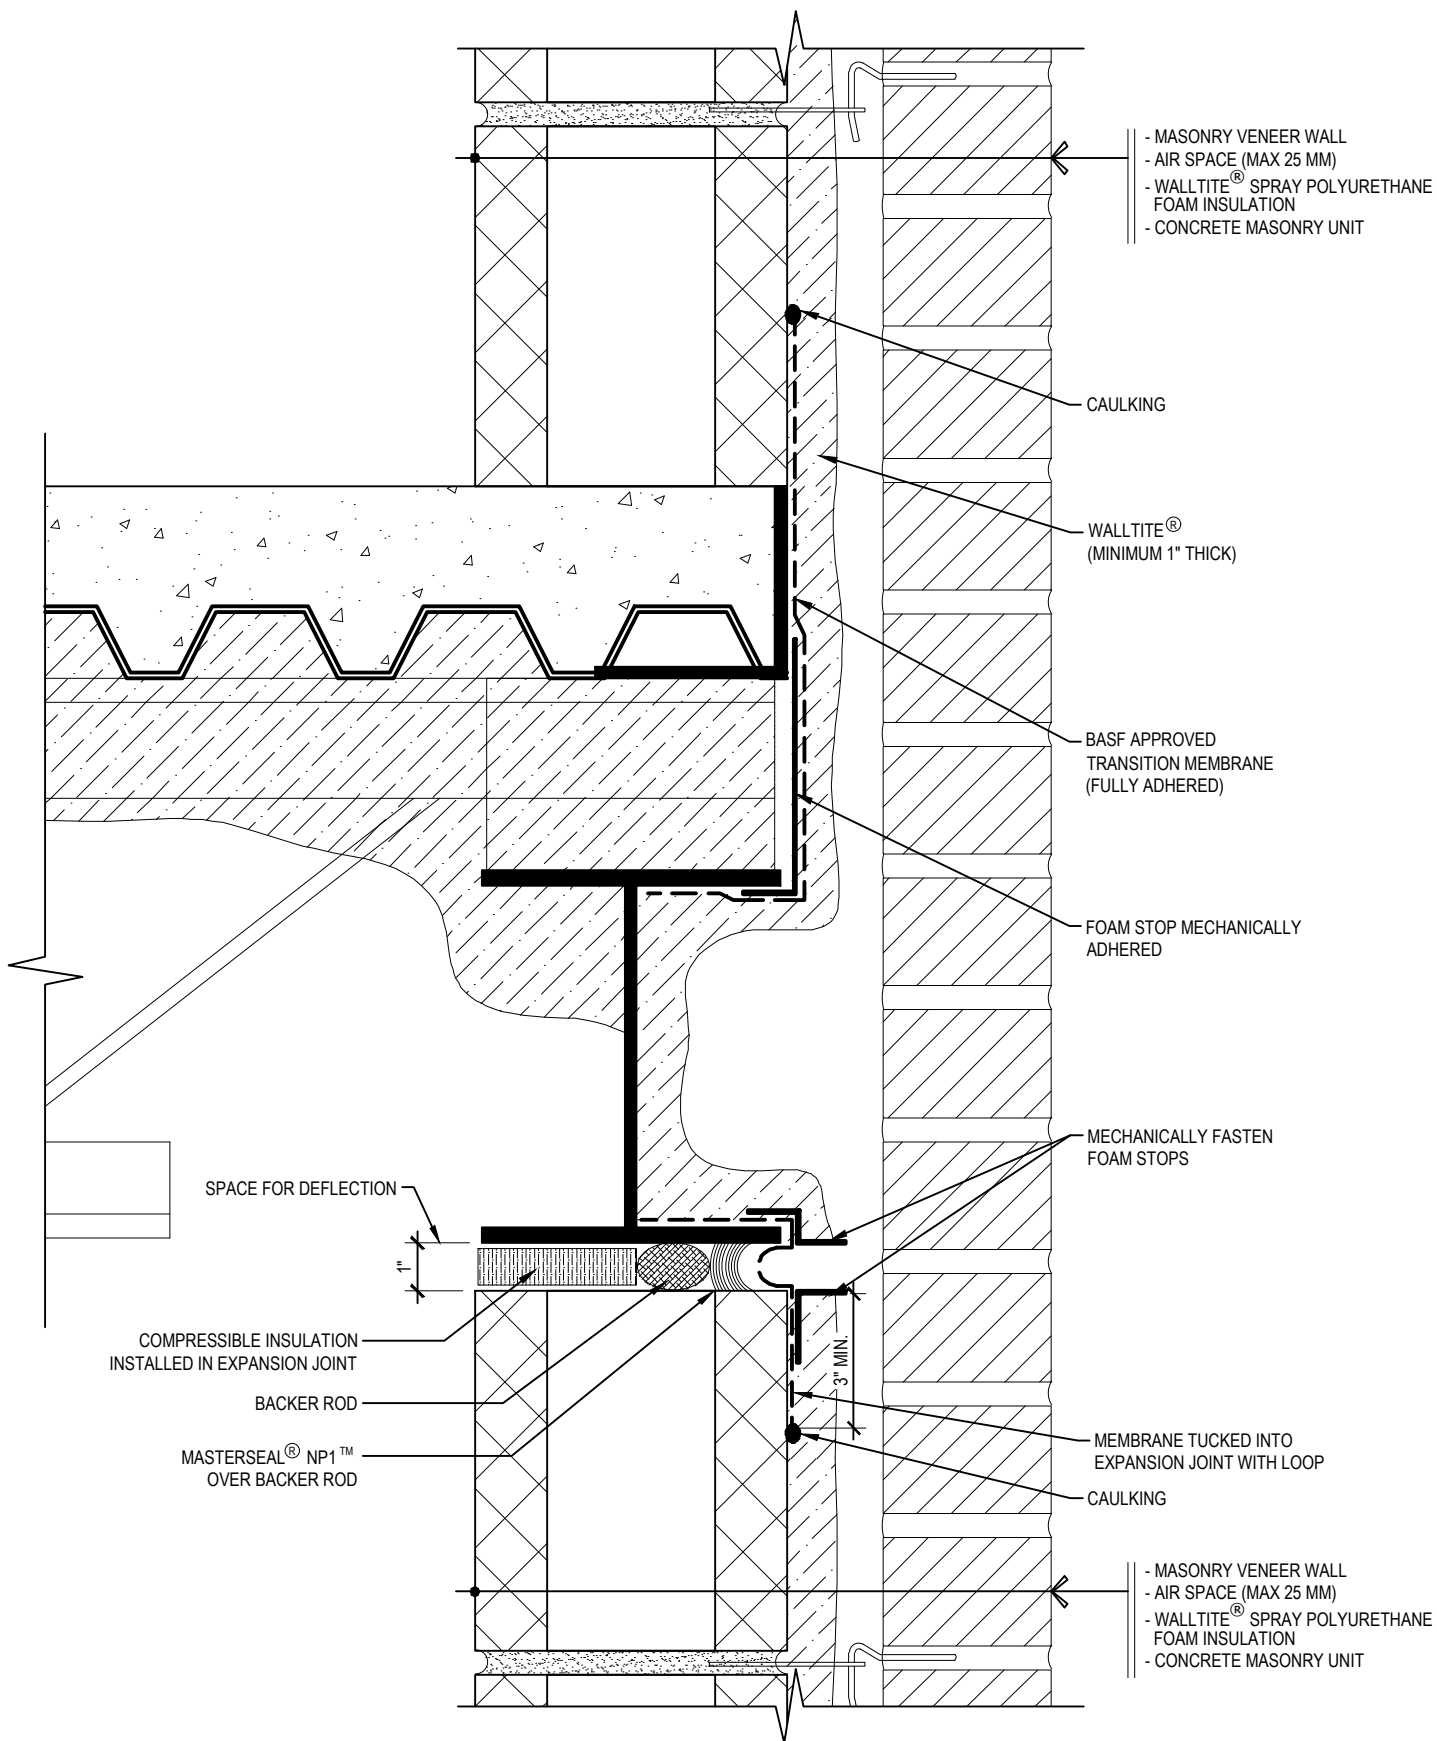
## WALL CORNER - HSS COLUMN

WALLTITE® AIR BARRIER SYSTEM,  
CONCRETE BLOCK ASSEMBLY

**BASF**  
We create chemistry

Drawing Number: WB-5	Scale: 3/4" = 1'-0"	Project no: M18 704	Date: APRIL 3, 2019	Designed by: C.J. & A.M.	Drawn by: C.C	Checked by: F.D.
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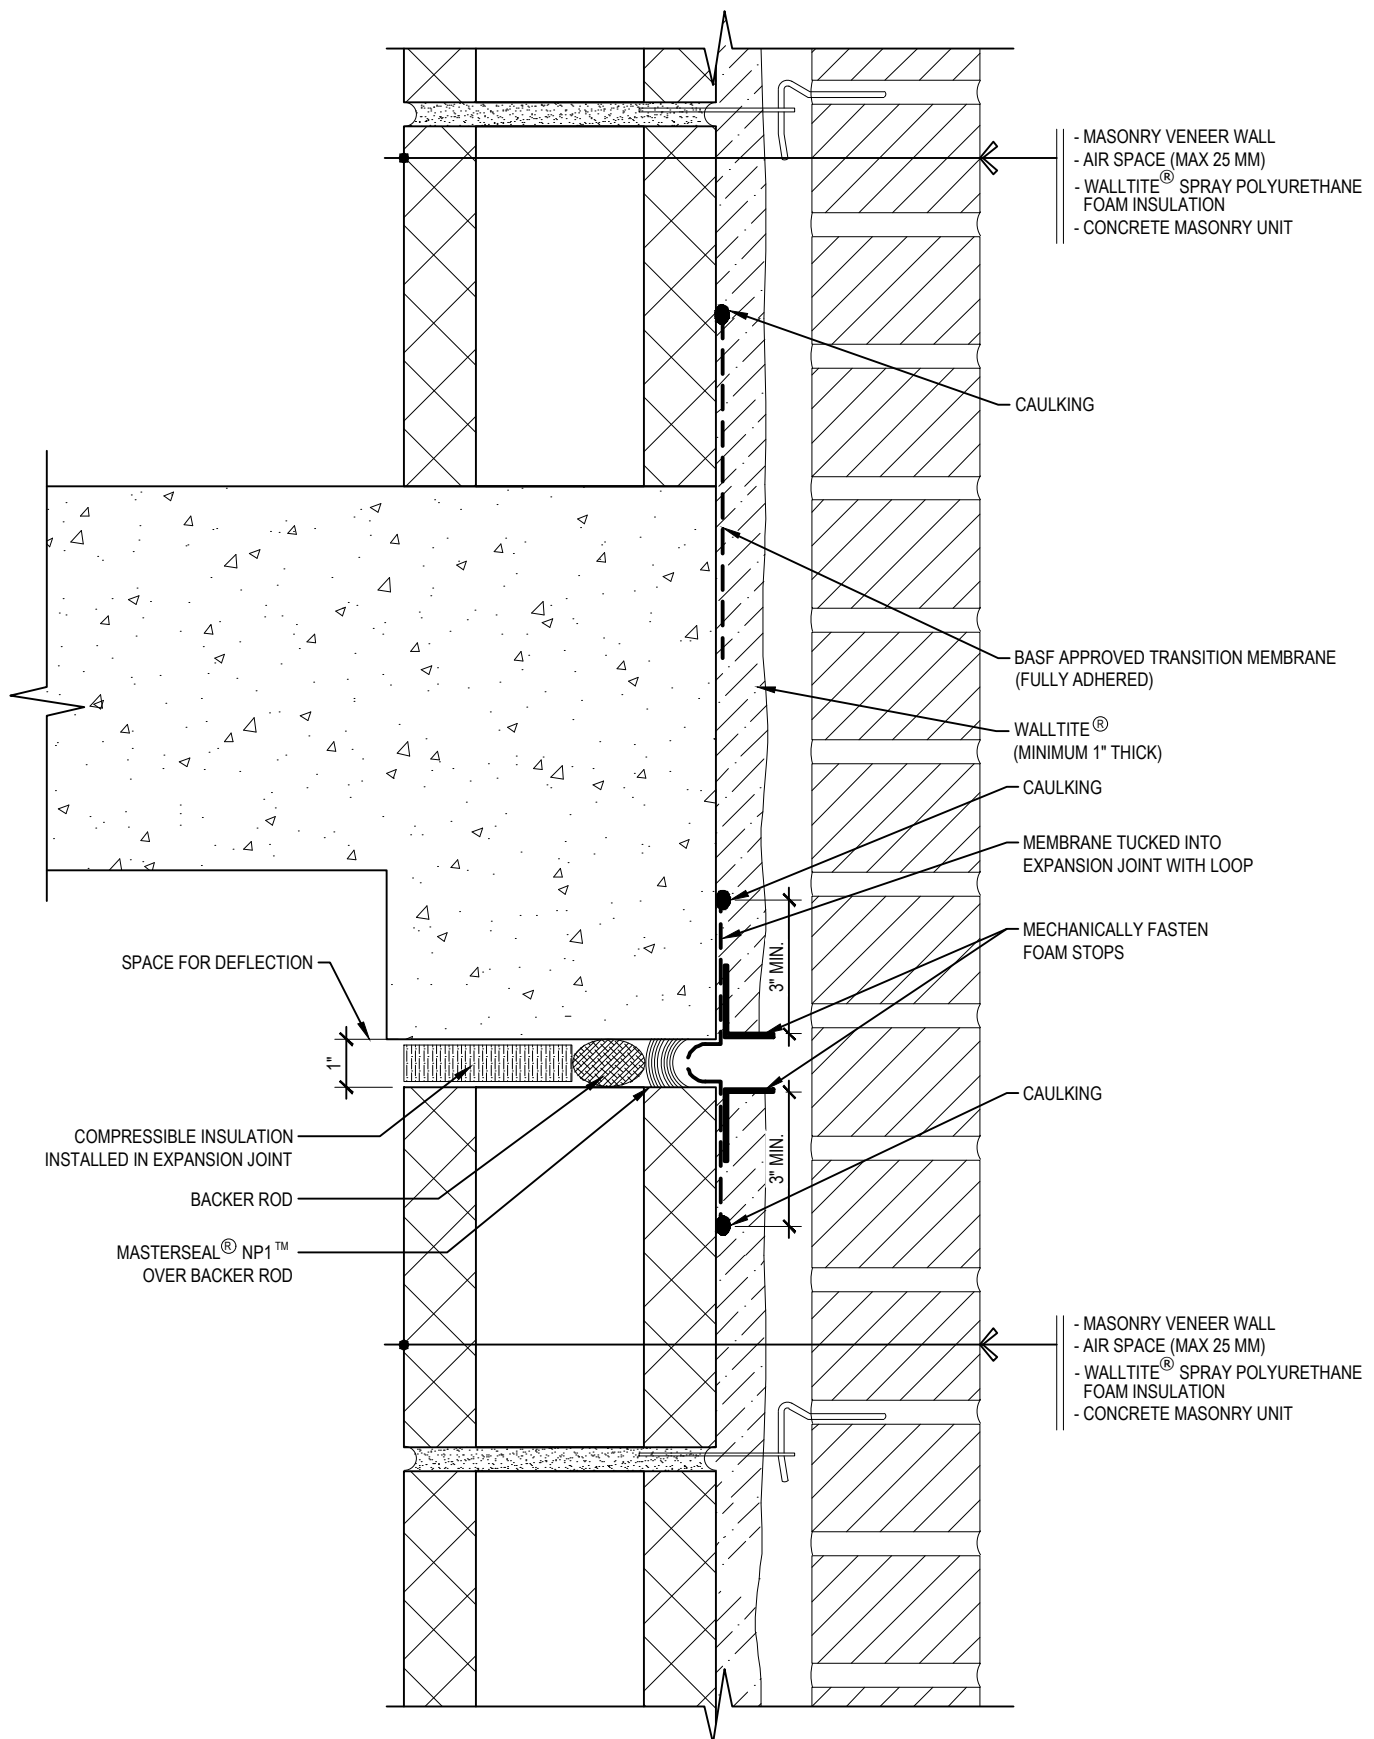
1  
WB-6A

# WALL TO FLOOR JUNCTION (STEEL DECK)

WALLTITE® AIR BARRIER SYSTEM,  
CONCRETE BLOCK ASSEMBLY

**BASF**  
We create chemistry

Drawing Number:	Scale:	Project no:	Date:	Designed by:	Drawn by:	Checked by:
WB-6A	3/4" = 1'-0"	M18 704	OCTOBER 24, 2019	C.J. & A.M.	C.C	F.D.



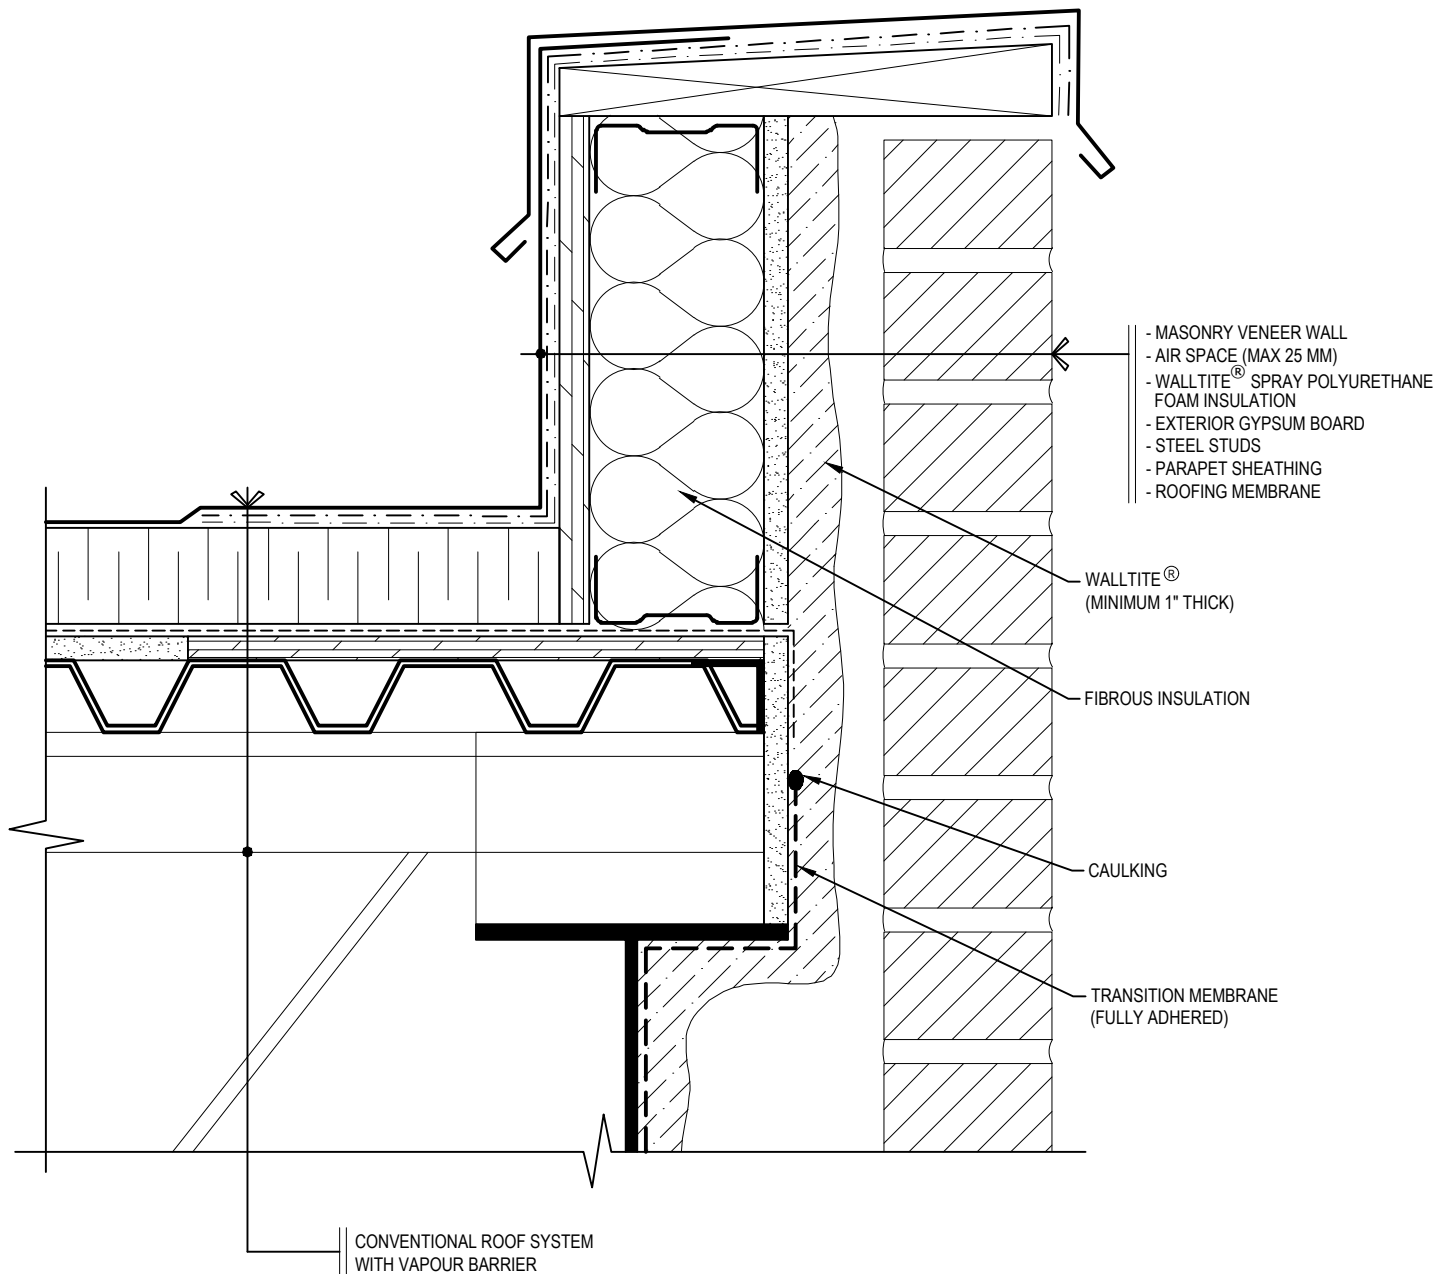
1  
WB-6B

# WALL TO FLOOR JUNCTION (CONCRETE FLOOR)

WALLTITE® AIR BARRIER SYSTEM,  
CONCRETE BLOCK ASSEMBLY

**BASF**  
We create chemistry

Drawing Number: WB-6B	Scale: 3/4" = 1'-0"	Project no: M18 704	Date: OCTOBER 24, 2019	Designed by: C.J. & A.M.	Drawn by: C.C	Checked by: F.D.
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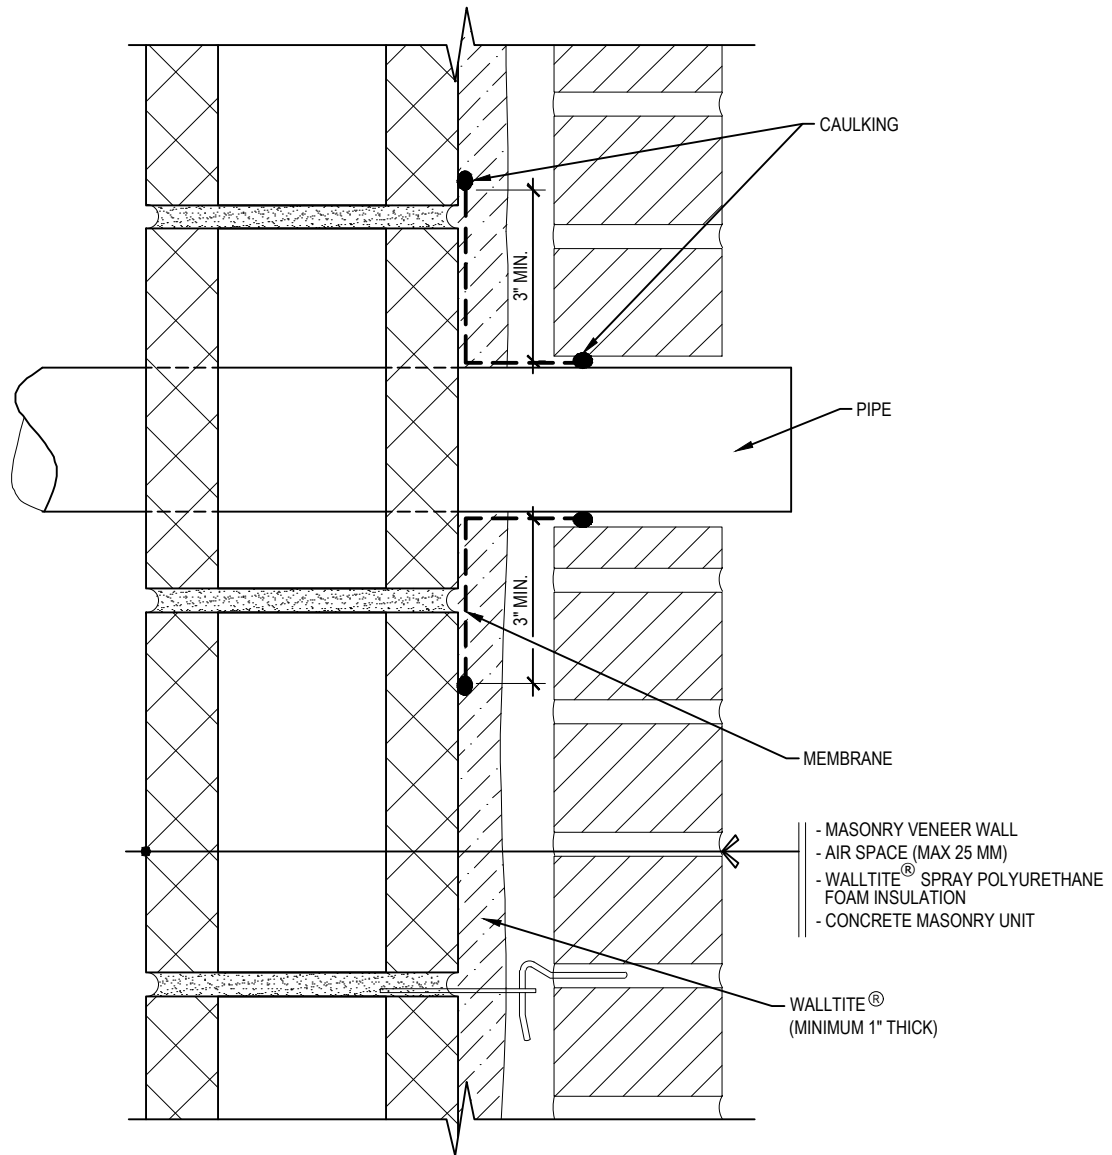
1  
WB-7

## WALL TO ROOF JUNCTION

WALLTITE® AIR BARRIER SYSTEM,  
CONCRETE BLOCK ASSEMBLY

**BASF**  
We create chemistry

Drawing Number: WB-7	Scale: 3/4" = 1'-0"	Project no: M18 704	Date: APRIL 3, 2019	Designed by: C.J. & A.M.	Drawn by: C.C	Checked by: F.D.
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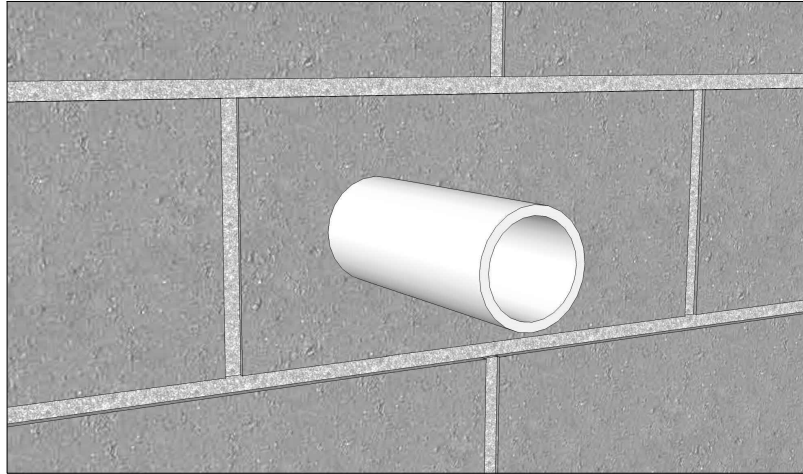
1  
WB-8A

## PENETRATION - 2D DETAIL

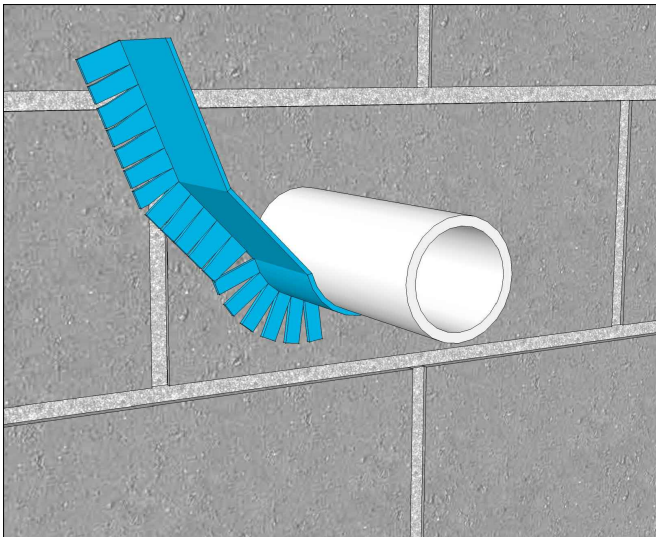
WALLTITE® AIR BARRIER SYSTEM,  
CONCRETE BLOCK ASSEMBLY

**BASF**  
We create chemistry

Drawing Number: WB-8A	Scale: 3/4" = 1'-0"	Project no: M18 704	Date: OCTOBER 24, 2019	Designed by: C.J. & A.M.	Drawn by: C.C	Checked by: F.D.
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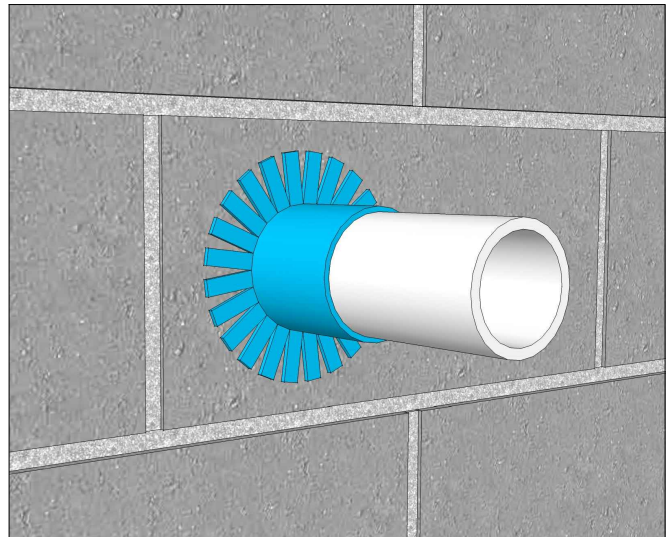


### STEPS FOR SEALING AROUND WALL PENETRATIONS



#### STEP 1.A

INSTALL A TRANSITION MEMBRANE AROUND THE PIPE.  
CUT THE EDGE OF THE MEMBRANE TO ENSURE THE MEMBRANE IS WELL ADHERED  
TO THE WALL AND ALONG THE PERIMETER OF THE PIPE.  
NOTE: INSTALL THE MEMBRANE STARTING FROM THE BOTTOM OF THE PIPE.



#### STEP 1.B

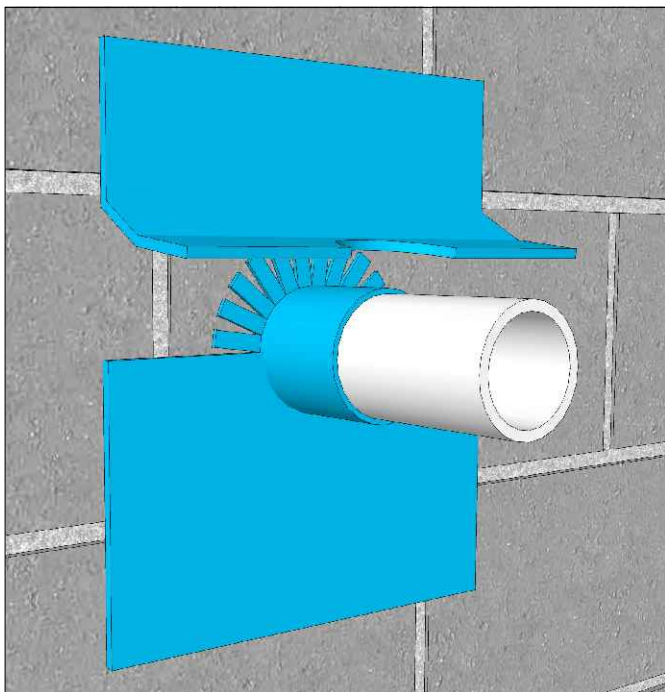


### PENETRATION - 3D DETAIL

WALLTITE® AIR BARRIER SYSTEM,  
CONCRETE BLOCK ASSEMBLY

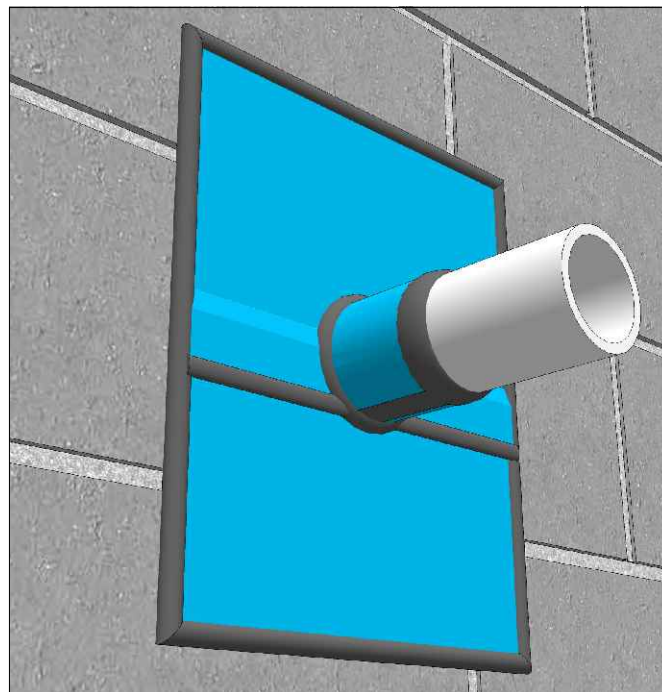
**BASF**  
We create chemistry

Drawing Number: WB-8B	Scale: 3/4" = 1'-0"	Project no: M18 704	Date: APRIL 3, 2019	Designed by: C.J. & A.M.	Drawn by: C.C	Checked by: F.D.
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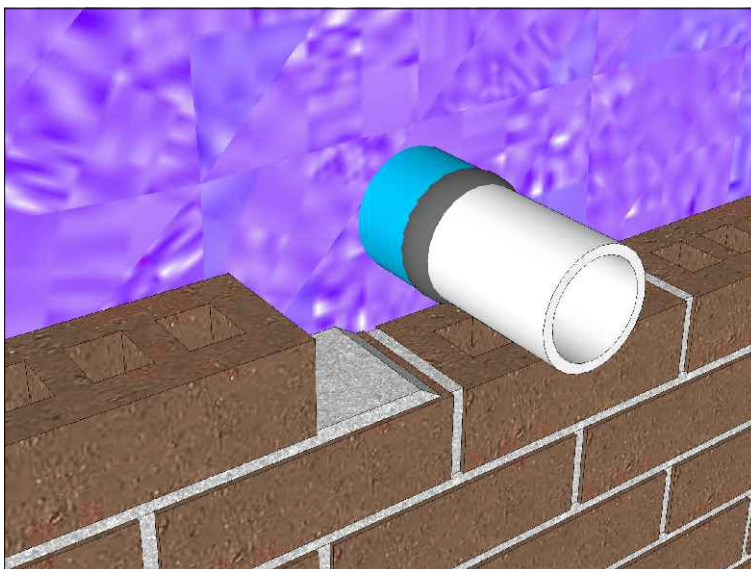
#### STEP 2

INSTALL A MEMBRANE ON THE WALL TO COVER THE LOWER HALF OF THE PIPE.



#### STEP 3

INSTALL A SECOND MEMBRANE ON THE WALL TO COVER THE UPPER PART OF THE PIPE AND OVERLAP WITH THE LOWER MEMBRANE.  
SEAL THE PERIMETER AND ALL THE MEMBRANE JOINTS.



#### STEP 4

SPRAY WALLTITE® BEFORE LAYING BRICKS.

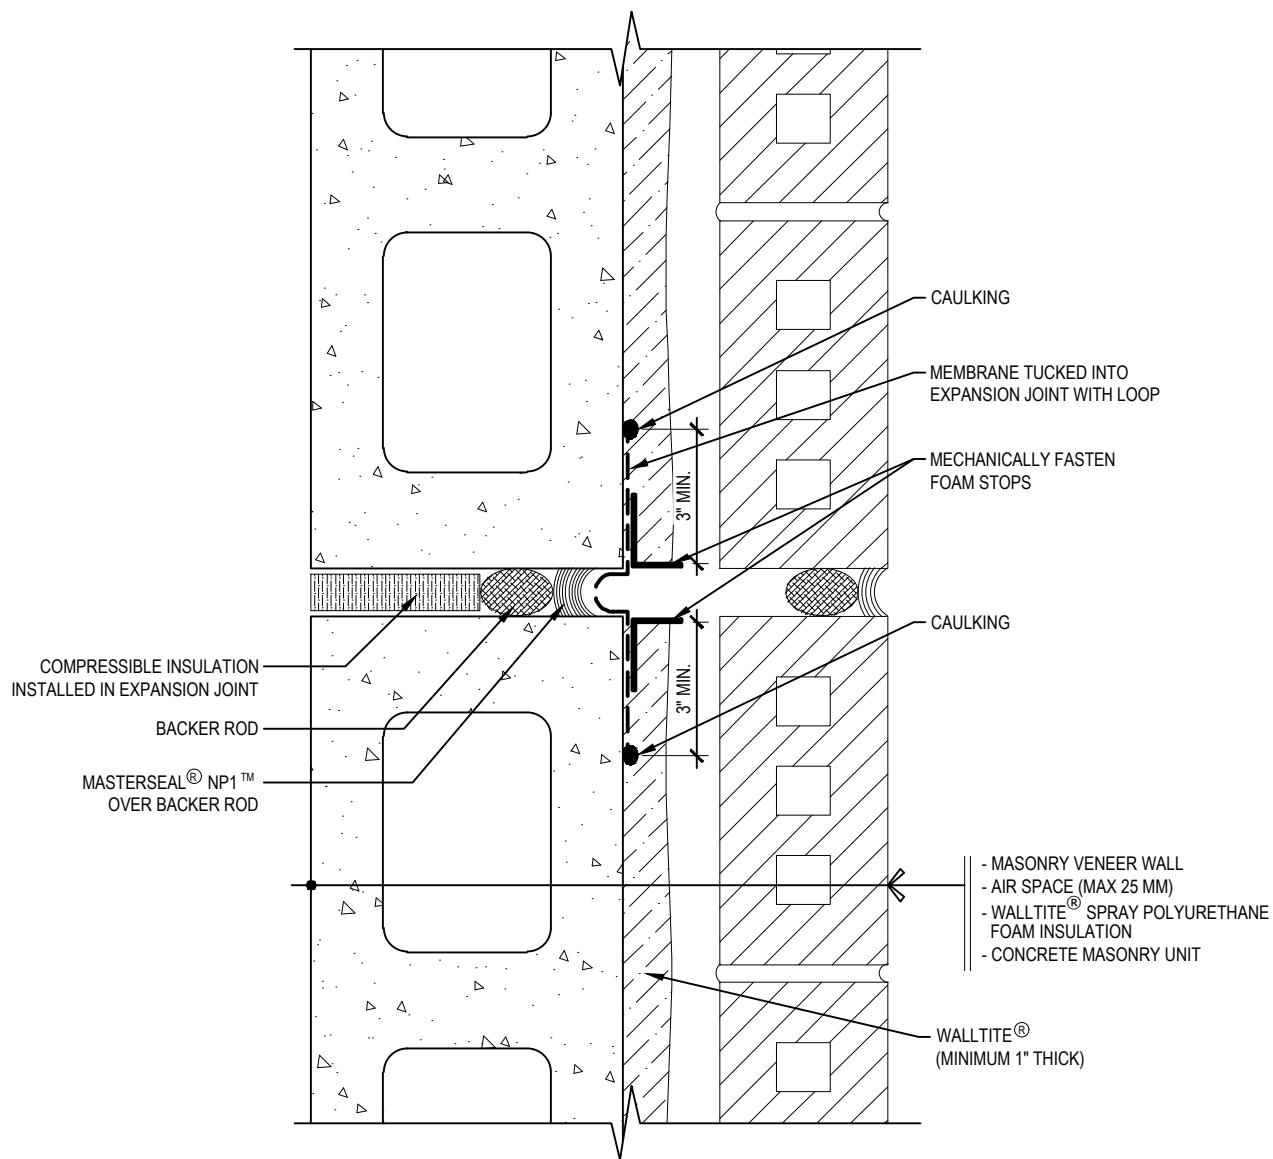


### PENETRATION - 3D DETAIL

WALLTITE® AIR BARRIER SYSTEM,  
CONCRETE BLOCK ASSEMBLY

**BASF**  
We create chemistry

Drawing Number: WB-8B	Scale: 3/4" = 1'-0"	Project no: M18 704	Date: APRIL 3, 2019	Designed by: C.J. & A.M.	Drawn by: C.C	Checked by: F.D.
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1  
WB-9

# MOVEMENT / CONTROL / EXPANSION JOINT DETAIL

WALLTITE® AIR BARRIER SYSTEM,  
CONCRETE BLOCK ASSEMBLY

**BASF**  
We create chemistry

Drawing Number: WB-9	Scale: 3/4" = 1'-0"	Project no: M18 704	Date: OCTOBER 24, 2019	Designed by: C.J. & A.M.	Drawn by: C.C	Checked by: F.D.
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